# PLANNING DRAWINGS FOR **PROPOSED ALTERATION. ALFRESCO AND** DETACHED SHED

# **AT 5 ATKINSON STREET, PORT FAIRY**

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ALL MATERIALS AND WORK PRACTICES SHALL COMPLY WITH, BUT NOT LIMITED TO THE BUILDING REGULATIONS 2018, NCC 2019 BCA VOL 2 AND ALL RELEVANT CURRENT AUSTRALIA STANDARDS (AS AMENDED) REFERRED TO THEREIN

UNLESS OTHERWISE SPECIFIED. THE TERM BCA SHALL REFER TO NATIONAL CONSTRUCTION CODE SERIES 2019 BUILDING CODE OF AUSTRALIA VOLUME

ALL MATERIALS AND CONSTRUCTION PRACTISE SHALL MEET PERFORMANCE REQUIREMENTS OF THE BCA. WHERE AN ALTERNATIVE SOLUTION IS PROPOSED THEN, PRIOR TO IMPLEMENTATION OR INSTALLATION, IT MUST FIRST BE ASSESSED AND APPROVED BY THE RELEVANT BUILDING SURVEYOR AS MEETING THE PERFORMANCE REQUIREMENTS OF THE BCA.

GLAZING, INCLUDING SAFETY GLAZING, SHALL BE INSTALLED TO A SIZE, TYPE AND THICKNESS SO AS TO COMPLY WITH: BCA PART 3.6 FOR CLASS 1 AND 10 BUILDINGS WITHIN A DESIGN WIND SPEEED OF NOT MORE THAN N3; AND NCC 2019 BCA VOL 1 PART B1.4 FOR CLASS 2 & 9 BUILDINGS.

WATERPROOFING OF WET AREAS, BEING BATHROOMS, SHOWERS, SHOWER ROOMS, LAUNDRIES, SANITARY COMPARTMENTS AND THE LIKE SHALL BE PROVIDED IN ACCORDANCE WITH AS3740.

THESE DRAWINGS SHALL BE READ IN CONJUNCTION WITH ANY HOUSE ENERGY RATING (HERS) REPORT AND SHALL BE CONSTRUCTIED IN ACCORDANCE WITH THE STAMPED PLANS ENDORSED BY THE ACCREDITED THERMAL PERFORMANCE ASSESSOR WITHOUT ALTERATION

STEP SIZES (OTHER THAN FOR SPIRAL STAIRS) TO BE: RISERS (R) 190mm MAXIMUM AND 115mm MINIMUM GOING (G) 355mm MAXIMUM AND 240mm MINIMUM 2R+1G = 700mm MAXIMUM ÁND 550mm MINIMUM WITH LESS THAN 125mm GAP BETWEEN OPEN TREADS

ALL TREADS, LANDINGS AND THE LIFE TO HAVE NON-SLIP FINISH OR SUITABLE NON-SKID STRIP NEAR EDGE OF NOSING.

PROVIDE BALUSTRADES WHERE CHANGE IN LEVEL EXCEEDS 1000mm ABOVE THE SURFACE BENEATH LANDINGS, RAMPS AND OR TREADS. BALUSTRADES (OTHER THAN TENSIONED WIRE BALUSTRADES) TO BE: 1000mm MINIMUM ABOVE FINISHED SURFACE LEVEL OF BALCONIES LANDINGS OR THE LIKE AND 865mm MINUMUM ABOVE FININSHED SRUFACE LEVEL OF STAIR NOSING OR RAMP AND VERTICAL WITH LESS THAN 125mm GAP BETWEEN, AND ANY HORIZONAL ELEMENT WITHIN THE BALUSTRADE BETWEEN 150mm AND 760mm ABOVE THE FLOOR MUST NOT FACILITATE CLIMBING WHERE CHANGES IN LEVEL EXCEEDS 4000mm ABOVE THE SURFACE BENEATH LANDINGS, RAMPS AND/ OR TREADS,

3.9.2.3 FOR CLASS 1 TO 10 BUILDINGS AND NCC 2019 BCA VOLUME 1 PART D2.16 FOR OTHER CLASSES OF BUILDINGS. TOP OF HANDRAILS TO BE A MINIMUM 865mm VERTICALLY ABOVE STAIR NOSING AND FLOOR SURFACE

WINDOW SIZES NOMINATED ARE NOMINAL ONLY. ACTUAL SIZE MAY VARY SUBJECT TO MANUFACTURER. WINDOWS AS PER MANUFACTURERS SPECIFICATION AND DETAILS.

WHERE THE BUILDING (EXCLUDES A DETATCHED CLASS 10) IS LOCATED IN A TERMITE PRONE AREA, THE AREA TO THE UNDERSIDE OF THE BUILDING AND THE PERIMETER IS TO BE TREATED AGAINST TERMITE ATTACK BUILDER TO PROVIDE MINIMUM CLEARANCE TO SUB FLOORS IN ACCORDANCE WITH AS3660 AND TREATMENT TO FLOORING SYSTEM AND PERIMETERS IN ACCORDANCE WITH AS3660

CONCRETE STUMPS: UP TO 1400mm LONG TO BE 100mm x 100mm (1No. H.D WIRE) 1401mm TO 1800mm LONG TO BE 100mm x 100mm (2No. H.D WIRES) 1801mm TO 3000mm LONG TO BE 125mm x 125mm (2 No.H.D WIRES) 100mm X 100mm STUMPS EXCEEDING 1200mm ABOVE GROUND LEVEL TO BE BRACED WHERE NO PERIMETER BASE BRICKWORK PROVIDED.

FOR BUILDINGS IN MARINE OR OTHER EXPOSURE ENVIRONMENTS SHALL HAVE MASONARY UNITS, MOTAR AND ALL BUILT IN COMPONENTS AND THE LIKE COMPLYING WITH THE DURABILITY REQUIREMMENTS OF TABLE 4.1 OF AS4773.1 PART 1: DESIGN

ALL STORMWATER TO BE CONNECTED TO LEGAL POINT OF DISCHARGE AS PER MUNICIPAL REQUIREMENTS AND APPROVAL.

THESE DRAWINGS ARE TO BE READ IN CONJUNCTION WITH ALL RELEVANT STRUCTURAL AND ALL OTHER SECONDARY CONSULTANTS DRAWINGS/ DETAILS AND WITH ANY OTHER WRITTEN INSTRUCTIONS ISSUED IN THE COURSE OF THE CONTRACT

SITE PLAN MEASUREMENTS IN METRES - ALL OTHER MEASUREMENTS ARE IN MILLIMENTRES U.N.O.

FIGURED DIMENSIONS TAKE PRECENDENCE OVER SCALED DIMENSONS.

THE BUILDER SHALL TAKE ALL STEPS NECESSARY TO ENSURE THE STABILITY AND GENERAL WATER TIGHTNESS OF ALL NEW AND/ OR EXISTING STRUCTURES DURING ALL WORKS.

THE BUILDER AND SUB CONTRACTORS SHALL CHECK AND VERIFY ALL DIMENSIONS, SETBACKS, LEVELS, SPECIFICATIONS AND ALL OTHER RELEVANTS DOCUMENTATION PRIOR TO THE COMMENCEMENT OF ANY WORKS, REPORT ALL DISCREPANCIES TO THIS OFFICE FOR CLARIFICATION.

INSTALLATION OF ALL SERVICES SHALL COMPLY WITH THE RESPECTIVE SUPPLY AUTHORITY REQUIREMENTS.

THE BUILDER AND SUBCONTRACTOR SHALL ENSURE THAT ALL STORMWATER DRAINS, SEWER PIPES AND THE LIKE ARE LOCATED AT A SUFFICIENT DISTANCE FROM ANY BUILDINGS FOOTING AND/ OR SLAB EDGE BEAMS SO AS TO PREVENT GENERAL MOISTURE PENETRATION, DAMPNESS, WEAKENING AND UNDERMINING OF ANY BUILDING AND ITS FOOTING SYSTEM.

THESE PLANS HAVE BEEN PREPARED FOR THE EXCLUSIVE USE BY THE CLIENT OF SHAPE BUILDING DESIGN. FOR THE PURPOSE EXPRESSLY NOTIFIED TO THE DESIGNER. ANY OTHER PERSON WHO USES OR RELIES ON THESE PLANS WITHOUT THE DESIGNERS WRITTEN CONSENT DOES SO AT THEIR OWN RISK AND NO RESPONSIBILITY IS ACCEPTED BY THE DESIGNER FOR SUCH USE AND/ OR RELIANCE.

THE APPROVAL BY THIS OFFICE OF A SUBSTITUTE MATERIAL, WORK PRACTICE, VARIATION OR THE LIKE IS NOT AN AUTHORISATION FOR ITS USE OR A CONTRACT VARIATION. ANY SAID VARIATIONS MUST BE ACCEPTED BY ALL PARTIES TO THE AGREEMENT AND WHERE APPLICABLE THE RELEVANT BUILDING SURVEYOR PRIOR TO IMPLEMENTING THE SAID VARIATION.

## **STORMWATER** (REFER TO ENGINEERS DESIGN)

100mm DIA. CLASS 6 UPVC STORMWATER LINE LAID TO A MINIMUM GRADE OF

1:100AND CONNECTED TO LEGAL POINT OF STORMWATER DISCHARGE. PROVIDE INSPECTION OPENINGS AT 9000mm C/C AND AT EACH CHANGE OF DIRECTION.

THE COVER TO UNDERGROUND STORMWATER DRAINS SHALL BE NOT LESS THAN

- 100mm UNDER SOIL
- 50mm UNDER PAVED OR CONCRETE AREAS
- 100mm UNDER UNREINFOCED CONCRETE OR PAVED DRIVEWAYS - 75mm UNDER REINFORCED CONCRETE DRIVEWAYS

### SITE ENVIRONMENT DESIGN INFORMATION SITE BUSHFIRE ATTACKASSEMENT (SIMPLIFIED METHOD)

REFERENCE DOCUMENT AS3959 RELEVANT FIRE DANGER INDEX (FDI) - (REFER TO BAL ASSESSMENT)

PREDOMINATE VEGETATION - (RÈFER TO BAL ASSESSMENT)

CLASSIFICATION - (REFER TO BAL ASSESSMENT) TYPE - (REFER TO BAL ASSESSMENT)

DISTANCE OF SITE FROM PREDOMINATE VEGETATION - (REFER TO BAL ASSESSMENT)

EFFECTIVE SLOPE OF LAND - (REFER TO BAL ASSESSMENT) DETERMINATION OF BUSHFIRE ATTACK LEVEL (BAL) - \*\* **TBC** \*\*

DATE 09/06/23 20/12/23 24/09/24 30/01/25



ISSUED DRAWINGS	REVISIONS
CONCEPT DRAWINGS	
DESIGN DEVELOPMENT DRAWINGS	
DESIGN DEVELOPMENT DRAWINGS	REV C
CONSTRUCTION DRAWINGS	
PLANNING DRAWINGS	

### SITE CLASSIFICATION

SITE CLASSIFICATION AS CLASS: (REFER TO SOIL REPORT BY OTHERS) REFER TO SOIL REPORT NO: (REFER TO SOIL REPORT BY OTHERS) BY: (REFER TO SOIL REPORT BY OTHERS)

DESIGN GUST WINDSPEED/ WIND CLASSIFICATION BUILDING TIE-DOWNS TO BE PROVIDED IN ACCORDANCE WITH AS1684 FOR AN ASSUMED DESIGN GUST WIND SPEED/ WIND CLASSIFICATION AS PER COUNCIL PROPERTY REPORT. (SUBJECT TO CONFIRMATION ON SITE BY RELEVANT BUILDING SURVEYOR AT FIRST INSPECTION) REFER TO AS1684 FOR CONSTRUCTION REQUIREMENTS.

CLIMATE ZONE

CLIMATE ZONE FOR THERMAL DESIGN/ THERMAL PERFORMANCE ASSESSMENT: ZONE 7

CORROSION PROTECTION OF BUILT IN STRUCTURAL MEMBERS PROVIDE CORROSION PROTECTION OF BUILT-IN STRUCTURAL STEEL MEMBERS SUCH AS STEEL LINTELS, SHELF ANGLES, CONNECTORS, ACCESSORIES (OTHER THAN WALL TIES) IN ACCORDANCE WITH TABLE 4.1 OF AS4773.1


### CORROSION PROTECTION OF SHEET ROOFING

PROVIDE CORROSION PROTECTION FOR SHEET ROOFING IN ACCORDANCE WITH BCA TABLE 3.5.1.1a SUITABLE FOR AN ENVIRONMENT CLASSICIATION OF RELEVANT ENVIRONMENT CLASSIFICATION.



# Shape Building Design

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# SITE LEVELS TO BE CONFIRMI

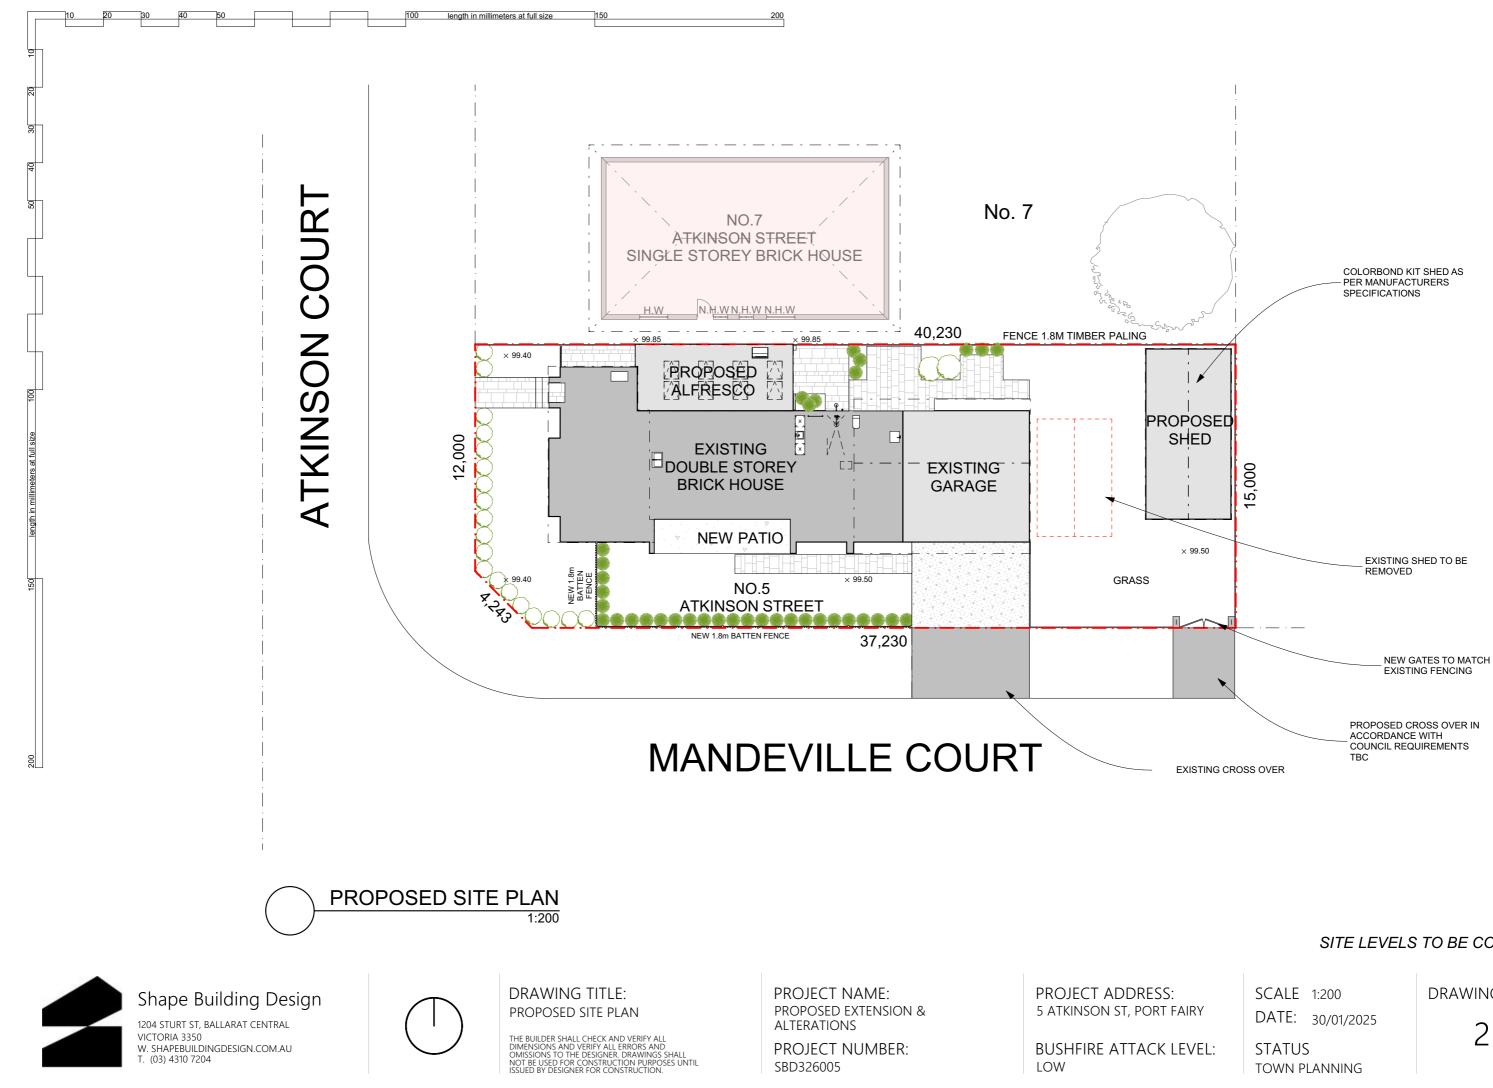


length in millimeters at full size



EXISTING FACADE

200



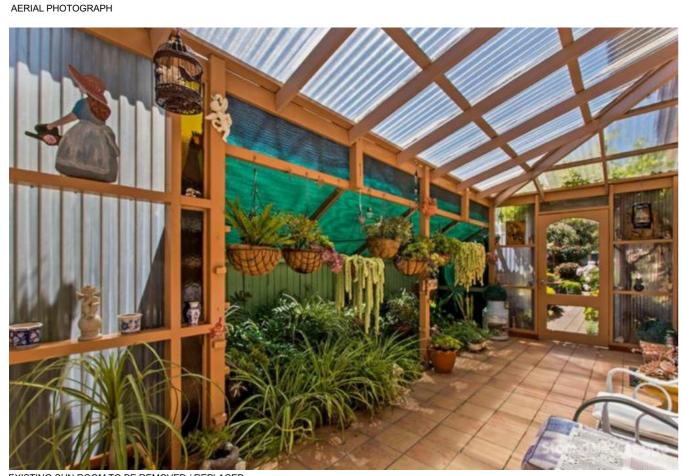

EXISTING SUN ROOM TO BE REMOVED / REPLACED

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# DRAWING TITLE: PHOTOGRAPHS

THE BUILDER SHALL CHECK AND VERIFY ALL DIMENSIONS AND VERIFY ALL ERRORS AND OMISSIONS TO THE DESIGNER. DRAWINGS SHALL NOT BE USED FOR CONSTRUCTION PURPOSES UNTIL ISSUED BY DESIGNER FOR CONSTRUCTION.

EXISTING FACADE

PROJECT NAME: PROPOSED EXTENSION & ALTERATIONS

PROJECT NUMBER: SBD326005

PROJECT ADDRESS: 5 ATKINSON ST, PORT FAIRY


BUSHFIRE ATTACK LEVEL: LOW




SCALE DATE: 30/01/2025

STATUS TOWN PLANNING



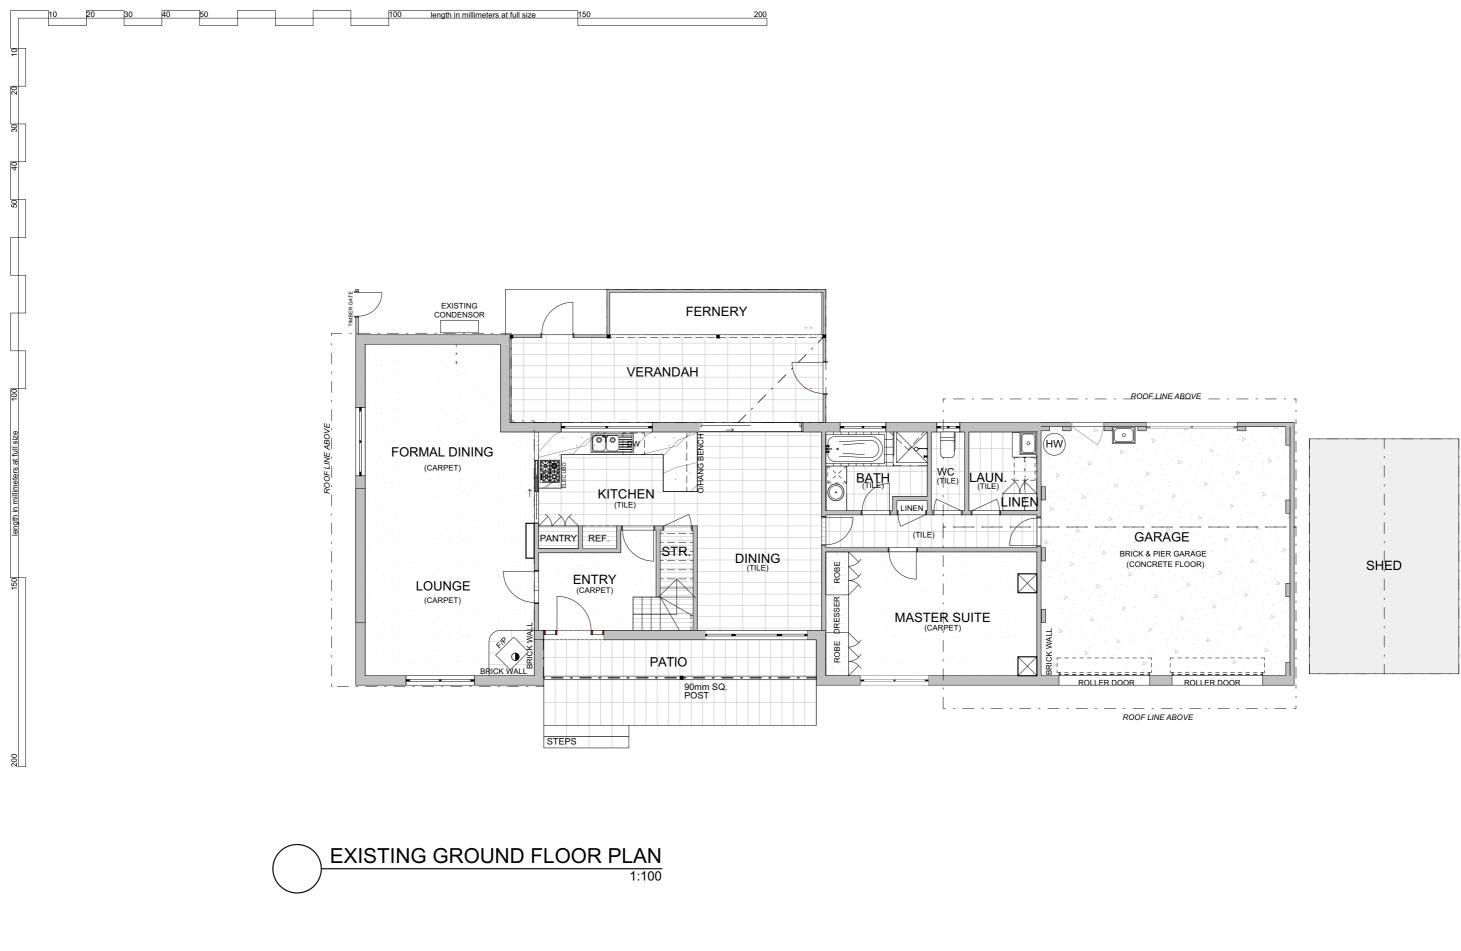



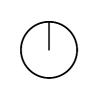


# DRAWING TITLE: EXISTING GROUND FLOOR

PLAN THE BUILDER SHALL CHECK AND VERIFY ALL DIMENSIONS AND VERIFY ALL ERRORS AND OMISSIONS TO THE DESIGNER. DRAWINGS SHALL NOT BE USED FOR CONSTRUCTION PURPOSES UNTIL ISSUED BY DESIGNER FOR CONSTRUCTION.

PROJECT NAME: PROPOSED EXTENSION & ALTERATIONS


PROJECT NUMBER: SBD326005

**PROJECT ADDRESS:** SCALE 1:100 DRAWING No. 5 ATKINSON ST, PORT FAIRY DATE: 30/01/2025 4 BUSHFIRE ATTACK LEVEL: STATUS LOW TOWN PLANNING

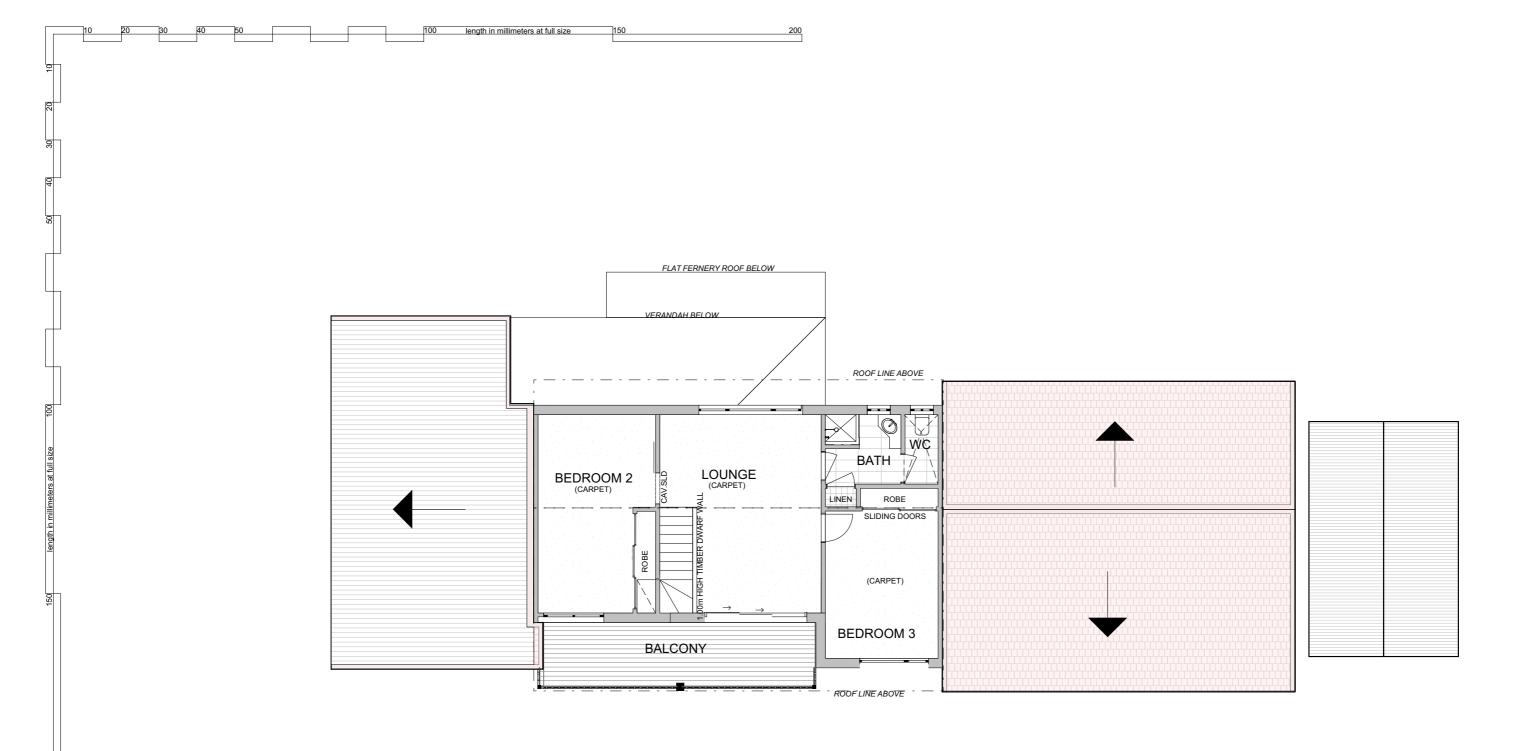





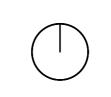

DRAWING TITLE: EXISTING UPPER FLOOR PLAN

THE BUILDER SHALL CHECK AND VERIFY ALL DIMENSIONS AND VERIFY ALL ERRORS AND OMISSIONS TO THE DESIGNER. DRAWINGS SHALL NOT BE USED FOR CONSTRUCTION PURPOSES UNTIL ISSUED BY DESIGNER FOR CONSTRUCTION. PROJECT NAME: PROPOSED EXTENSION & ALTERATIONS


PROJECT NUMBER: SBD326005

PROJECT ADDRESS: 5 ATKINSON ST, PORT FAIRY

BUSHFIRE ATTACK LEVEL: LOW


SCALE 1:100 DATE: 30/01/2025 DRAWING No.

STATUS TOWN PLANNING

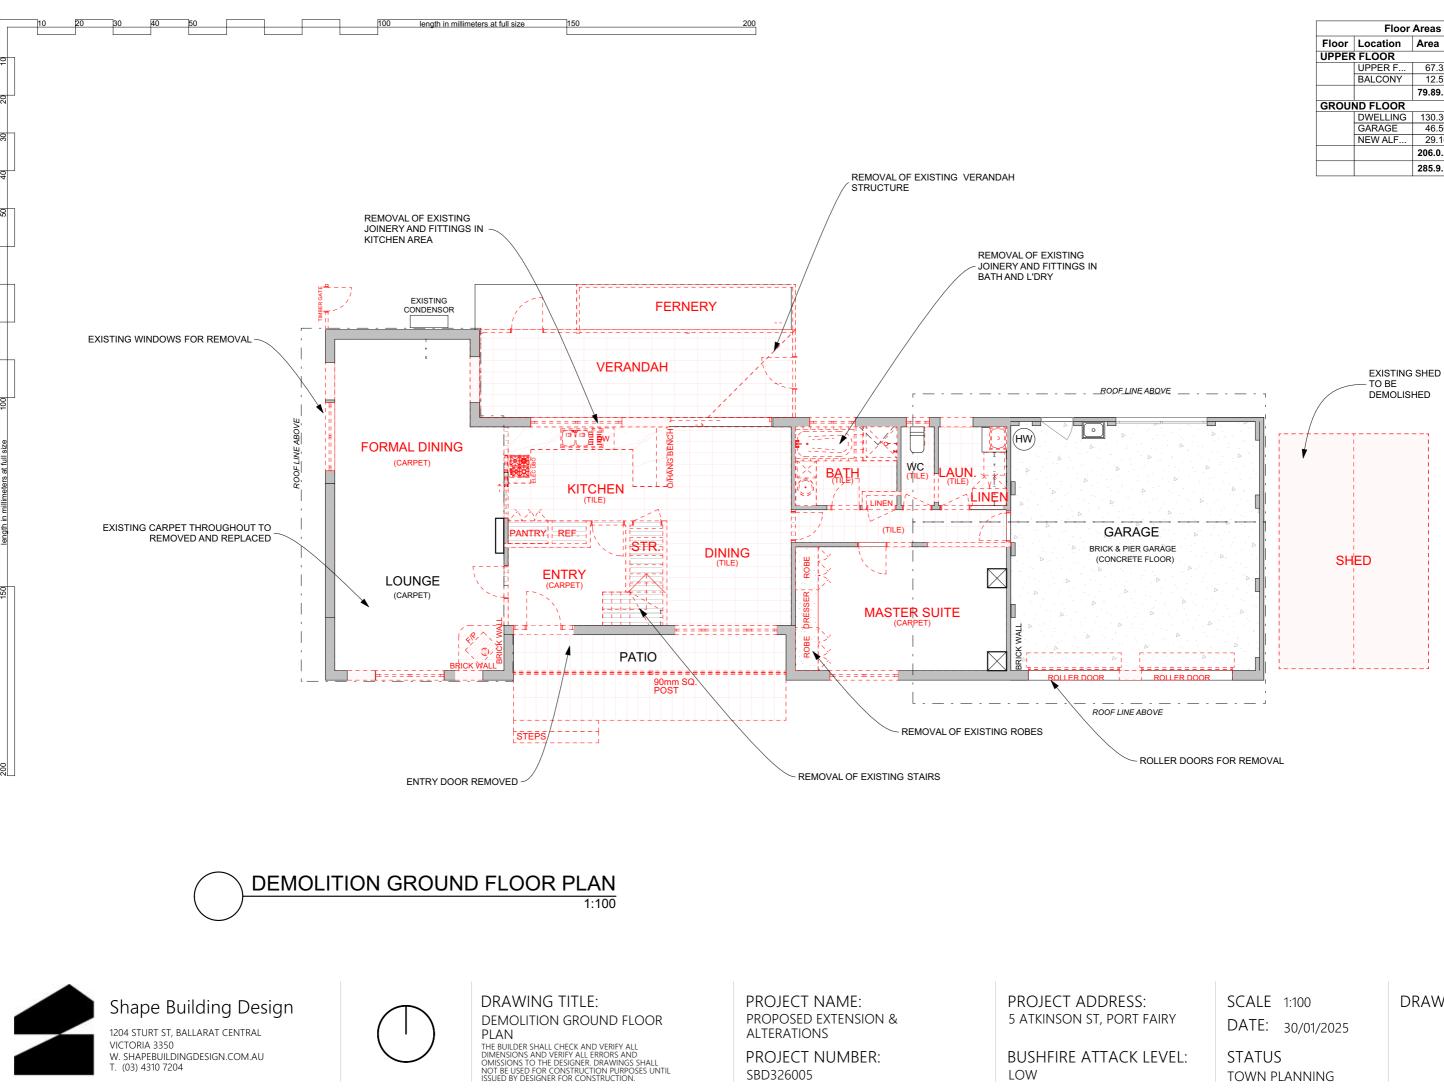

	Floor	Areas	
Floor	Location	Area	Perimeter
UPPER	FLOOR		
	UPPER F	67.32	44.03
	BALCONY	12.57	17.86
		79.89	61.89 m
GROUI	ND FLOOR		
	DWELLING	130.36	65.65
	GARAGE	46.50	27.28
	NEW ALF	29.16	23.77
		206.0	116.70 m
		285.9	178.59 m


DRAWING No. 6 TOWN PLANNING

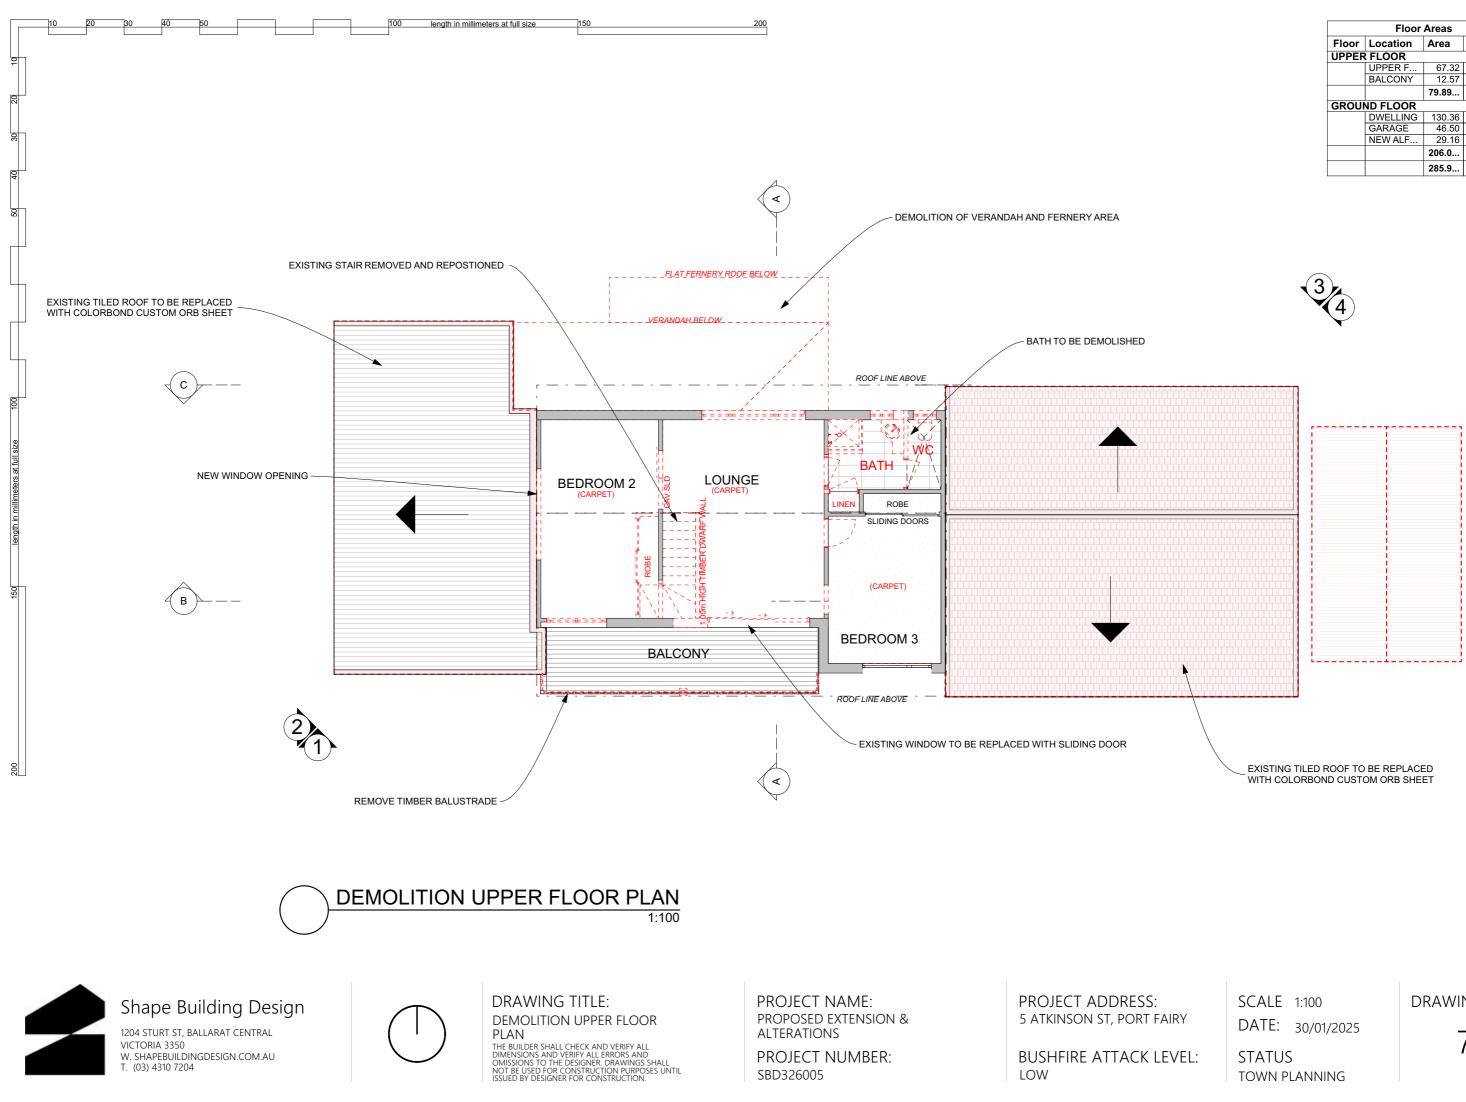


	Floor	Areas	
Floor	Location	Area	Perimeter
UPPER	FLOOR		
	UPPER F	67.32	44.03
	BALCONY	12.57	17.86
		79.89	61.89 m
GROUI	ND FLOOR		
	DWELLING	130.36	65.65
	GARAGE	46.50	27.28
	NEW ALF	29.16	23.77
		206.0	116.70 m
		285.9	178.59 m






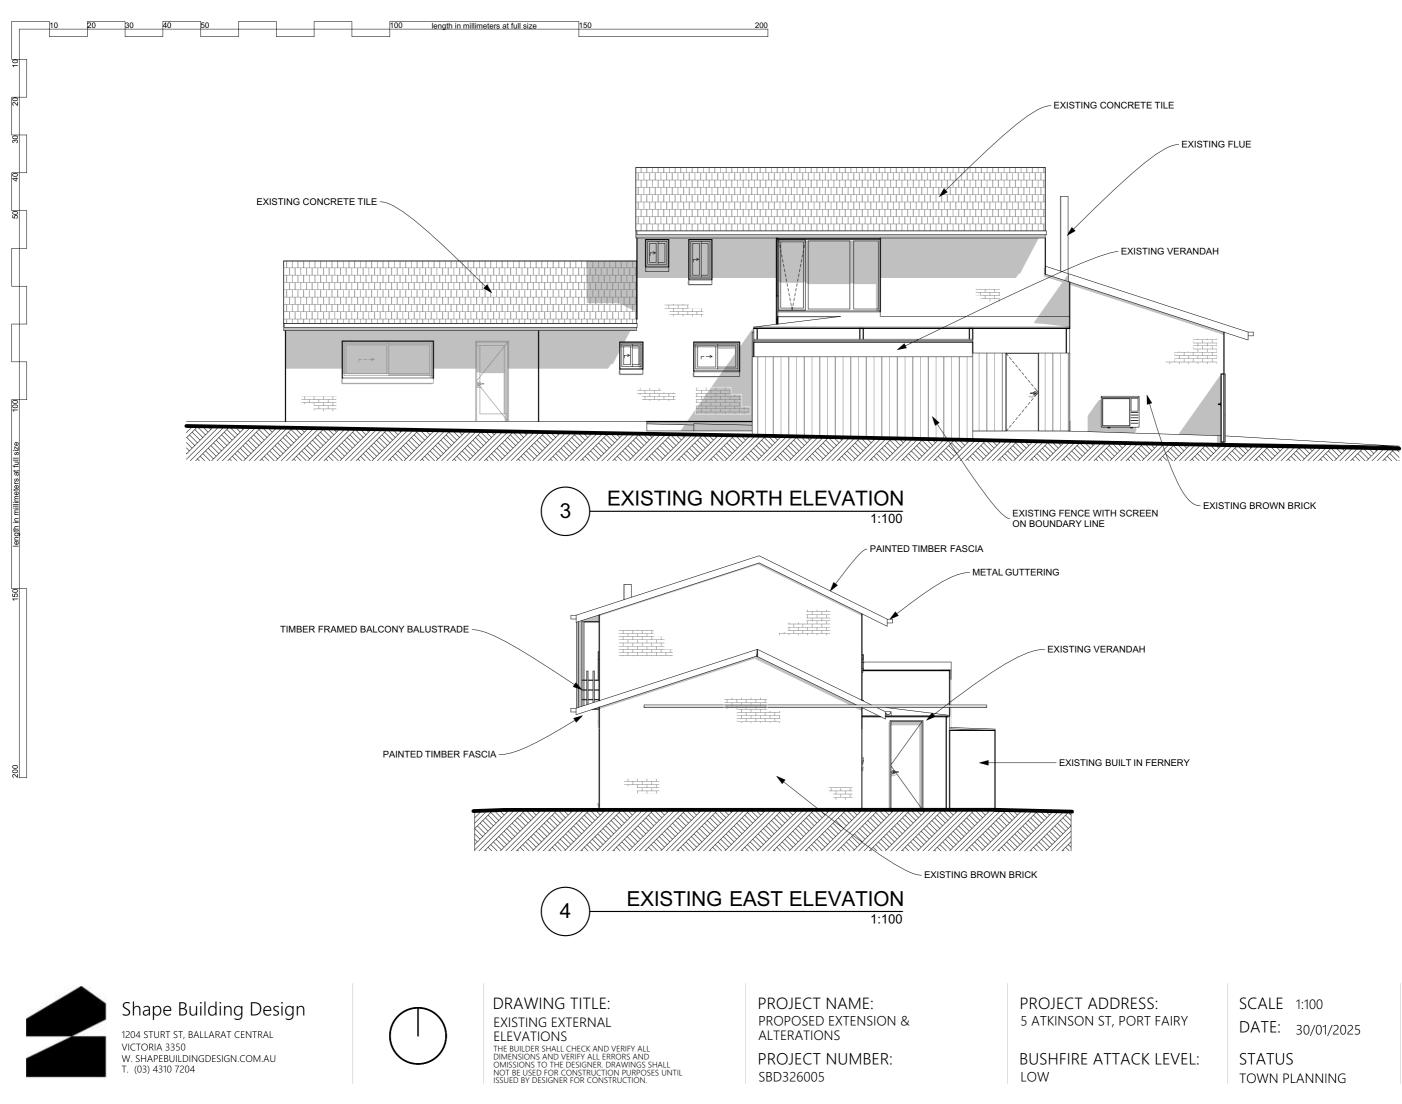




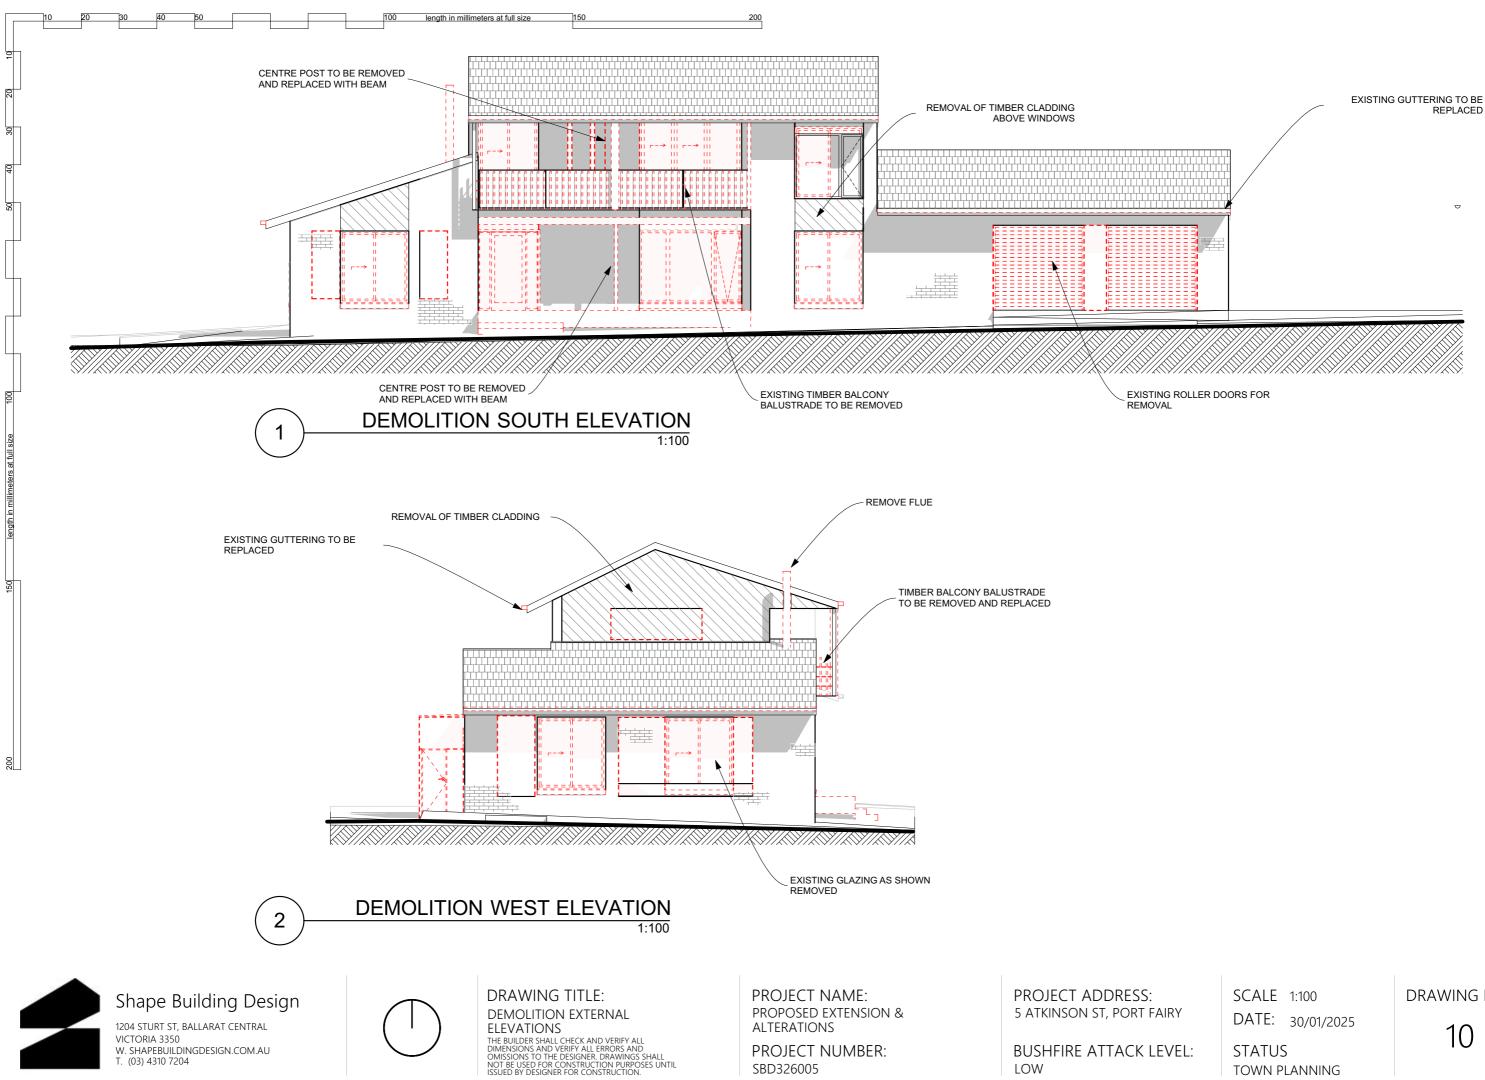

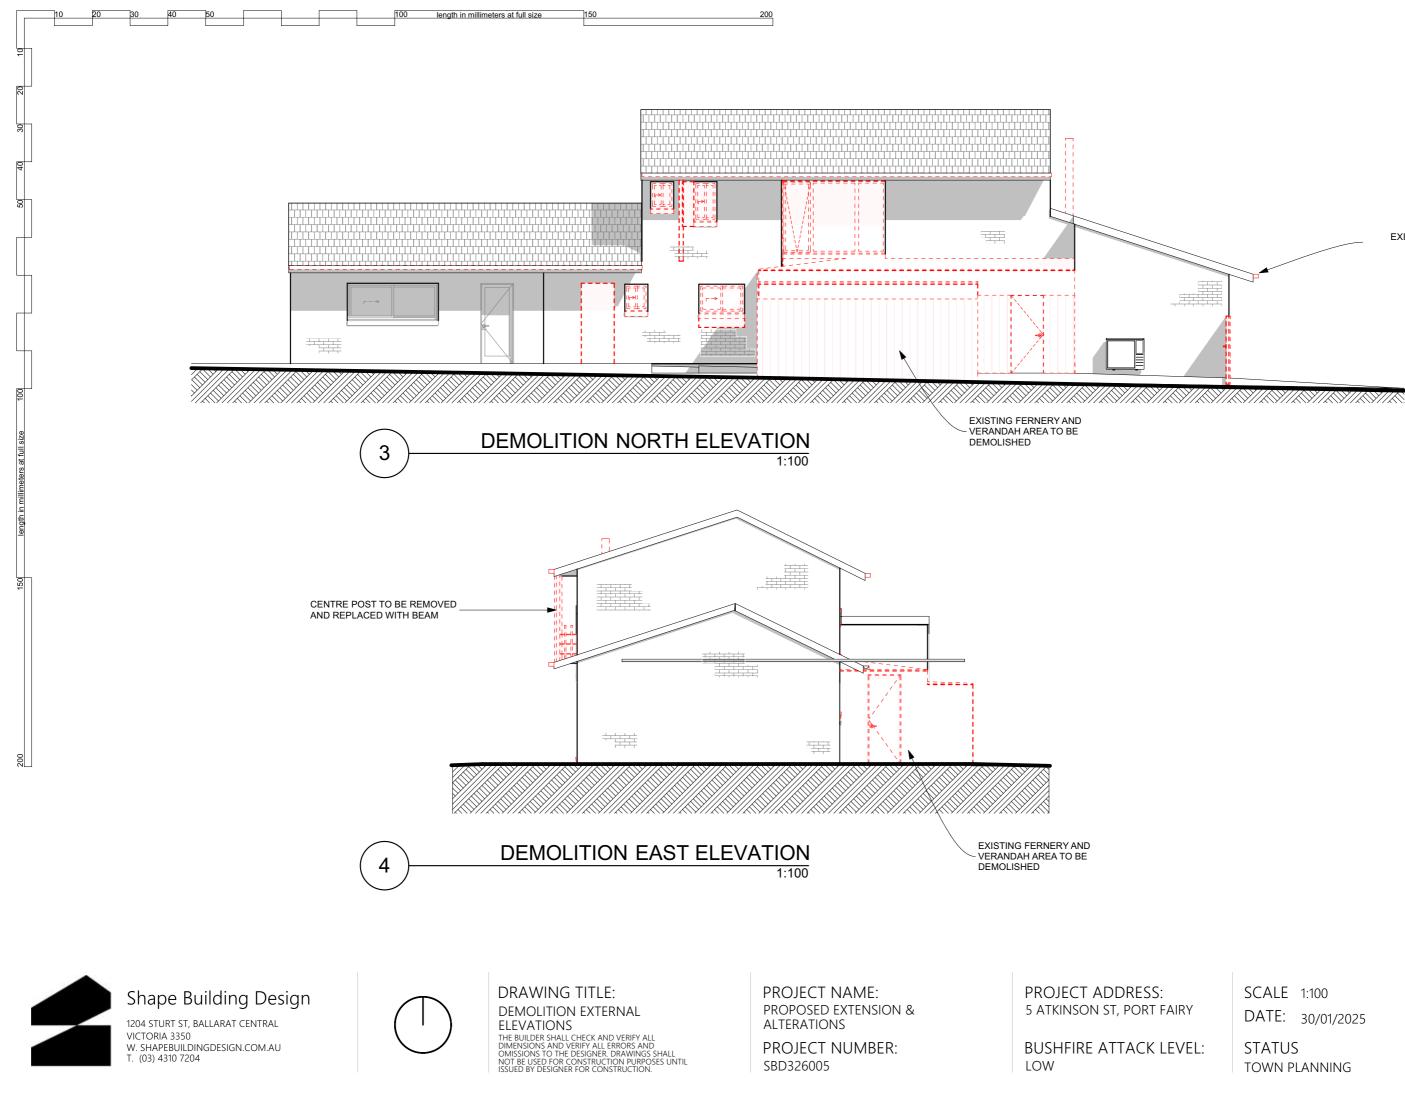

EXISTING GUTTERING TO BE REPLACED

DRAWING No.

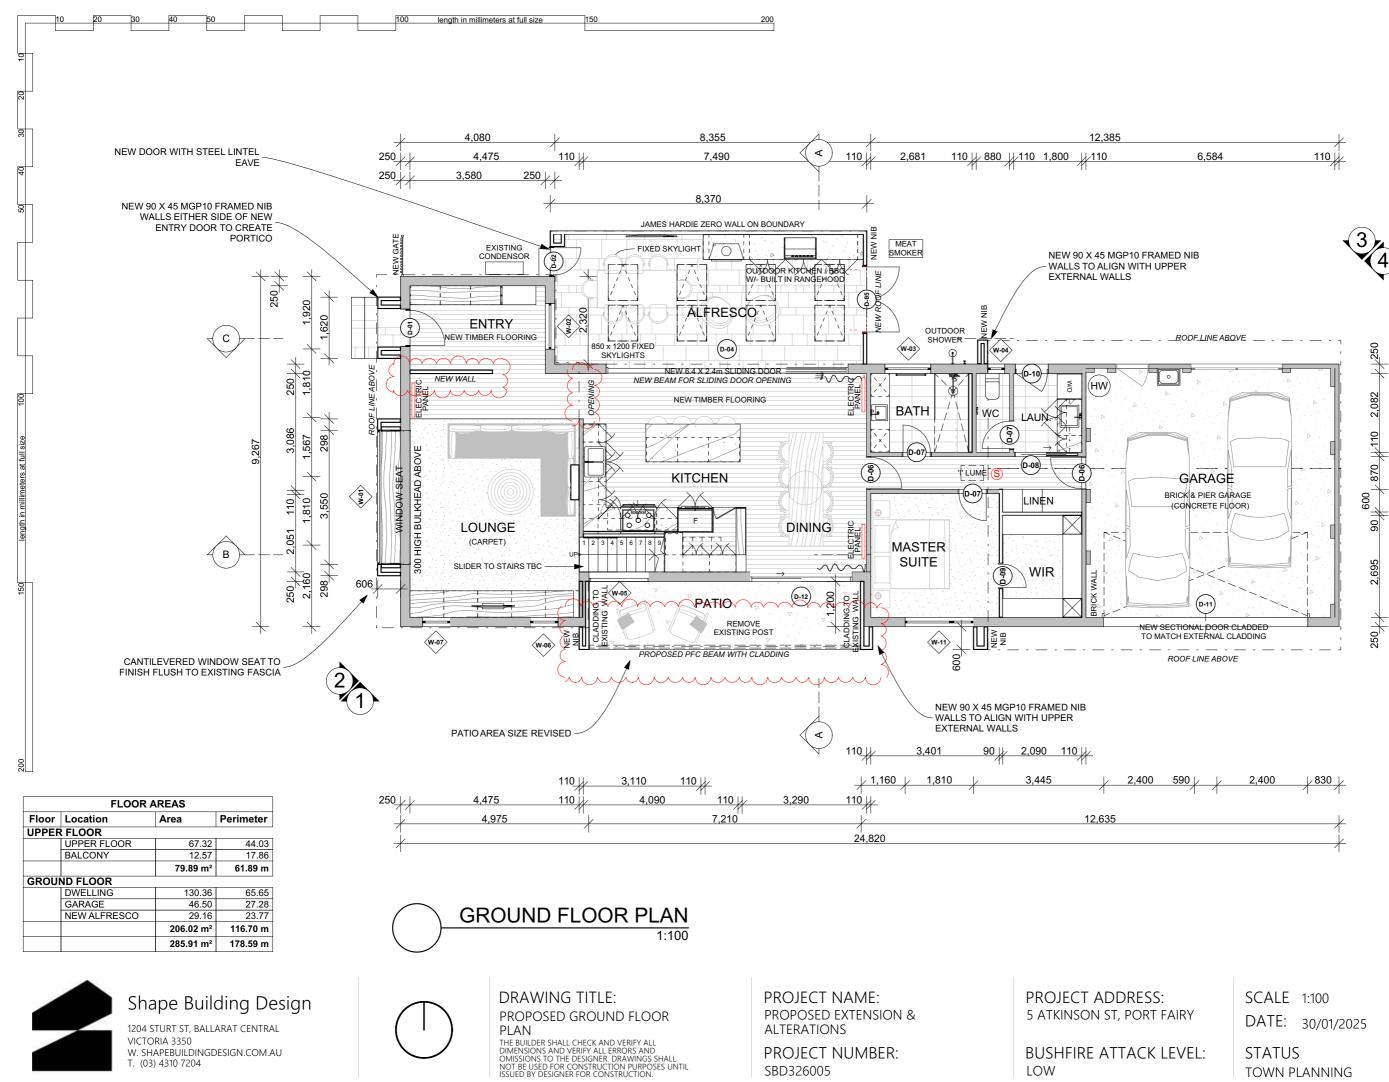


SBD326005


LOW


TOWN PLANNING


DRAWING No.

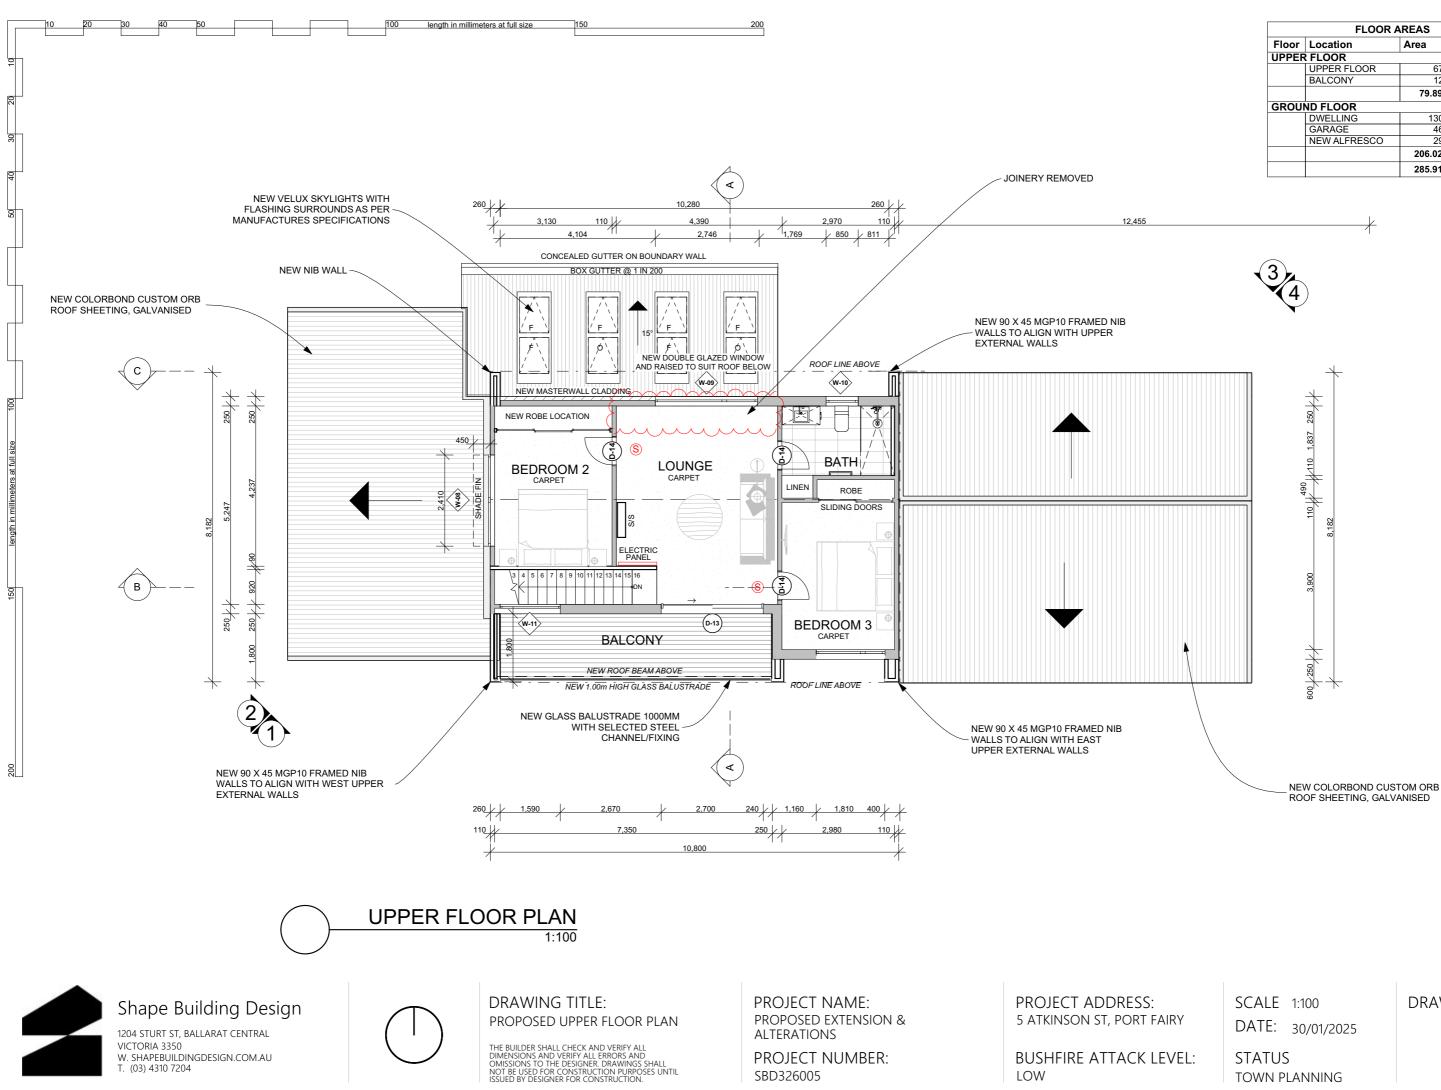

	FLOOR A	AREAS	
Floor	Location	Area	Perimeter
UPPER	FLOOR	•	
	UPPER FLOOR	67.32	44.03
	BALCONY	12.57	17.86
		79.89 m²	61.89 m
GROUI	ND FLOOR		
	DWELLING	130.36	65.65
	GARAGE	46.50	27.28
	NEW ALFRESCO	29.16	23.77
		206.02 m <sup>2</sup>	116.70 m
		285.91 m <sup>2</sup>	178.59 m

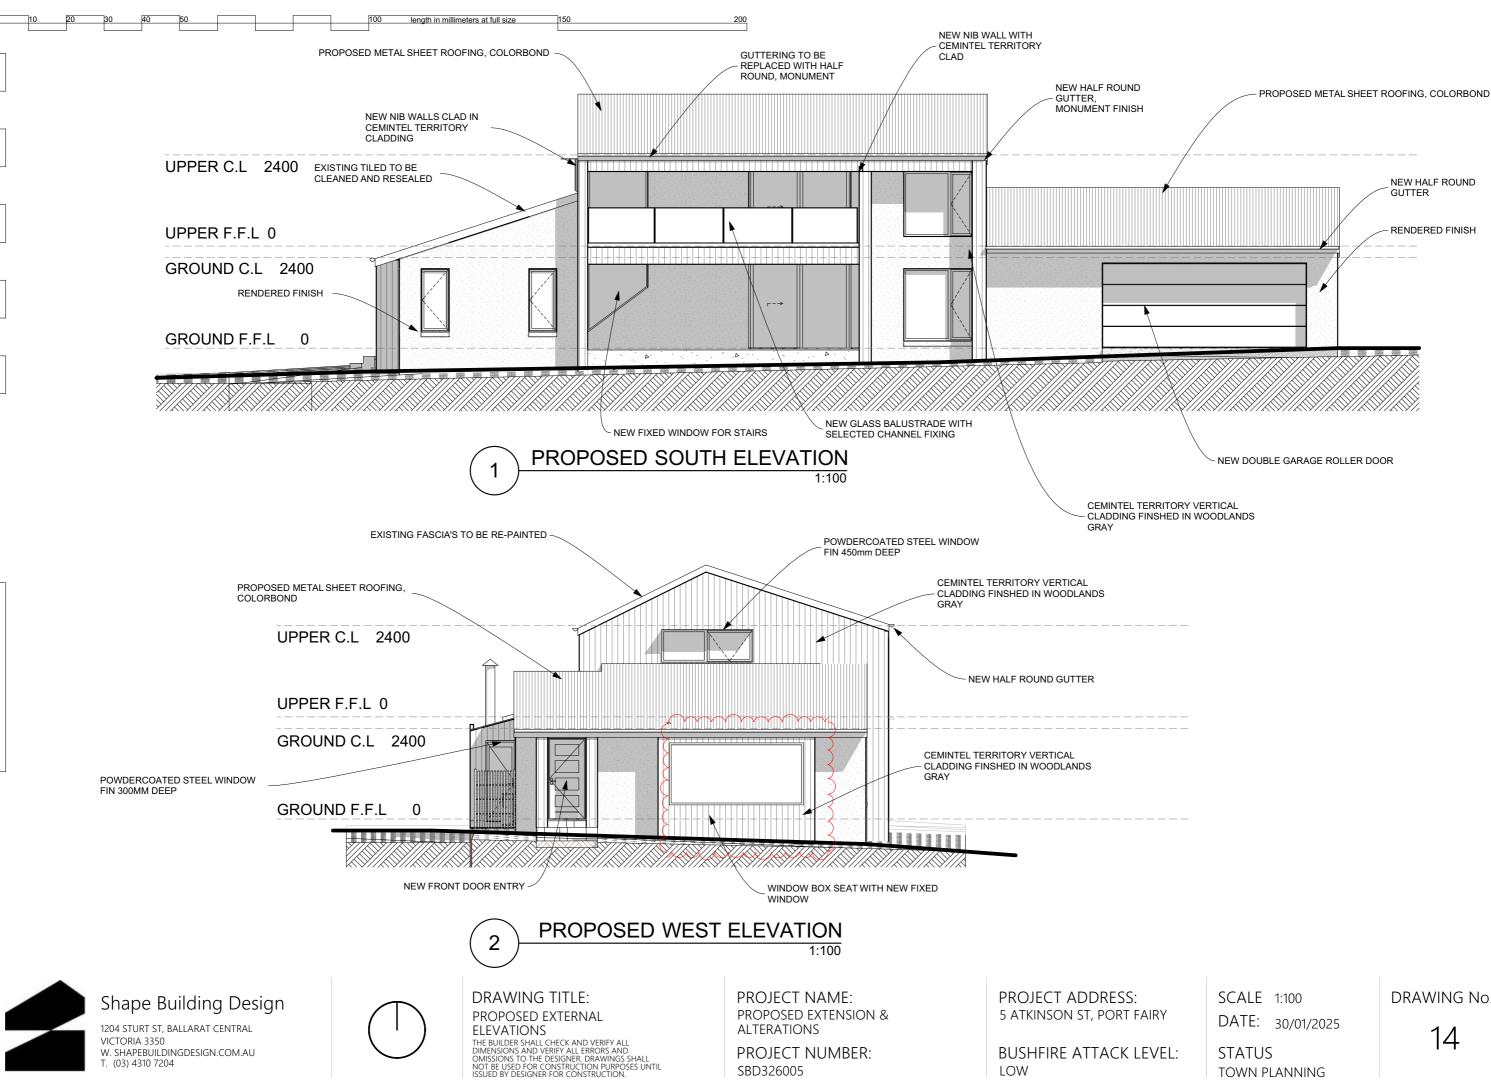

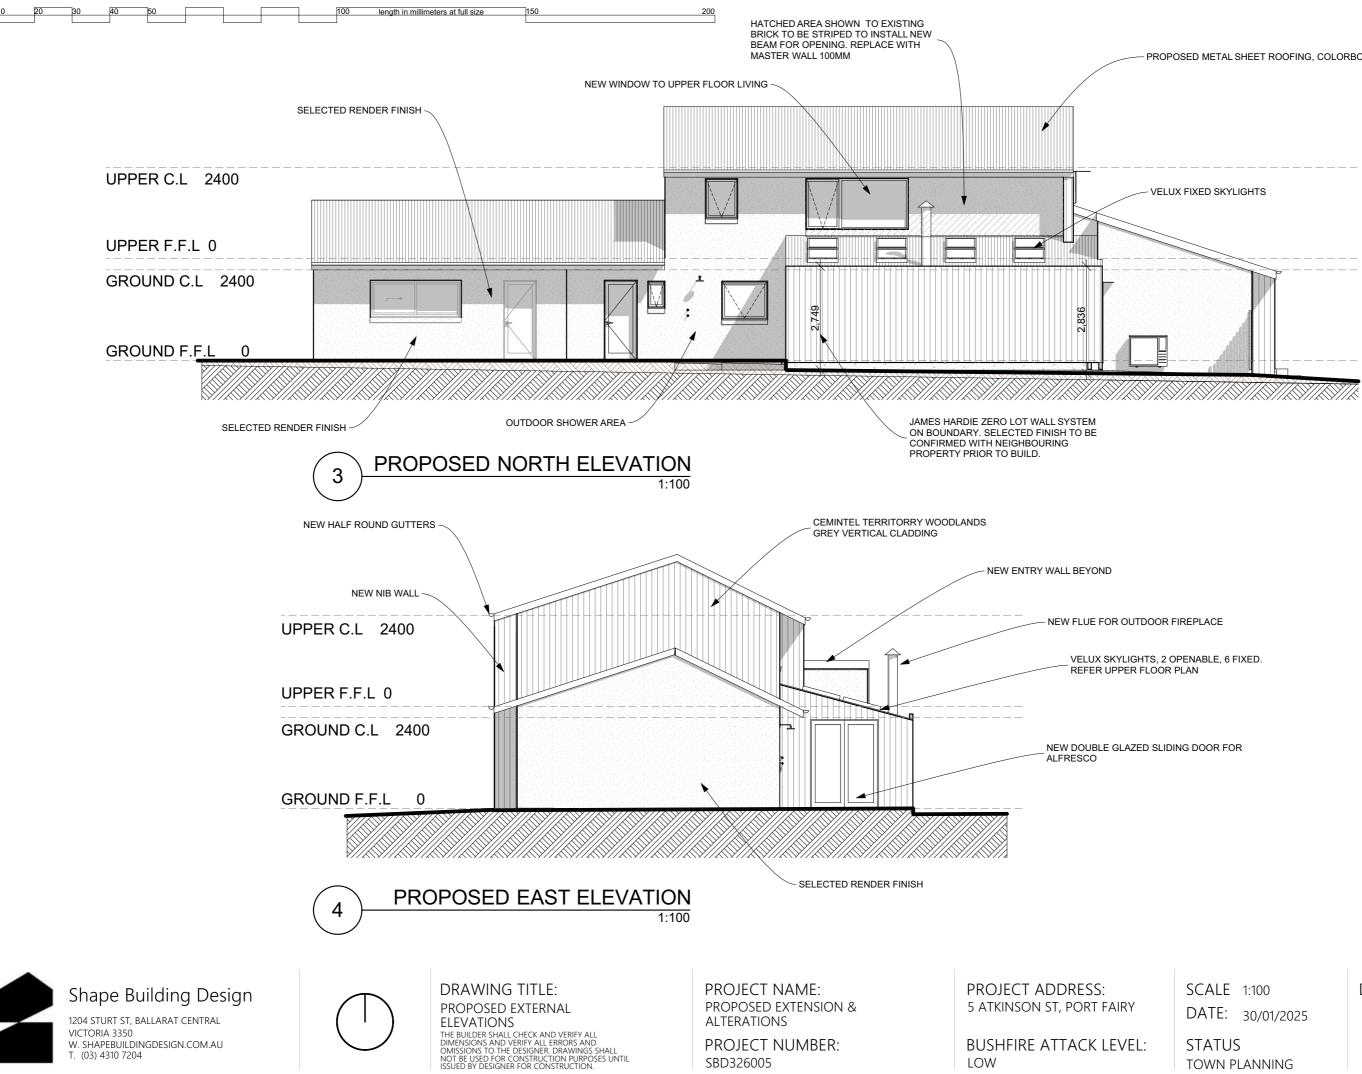

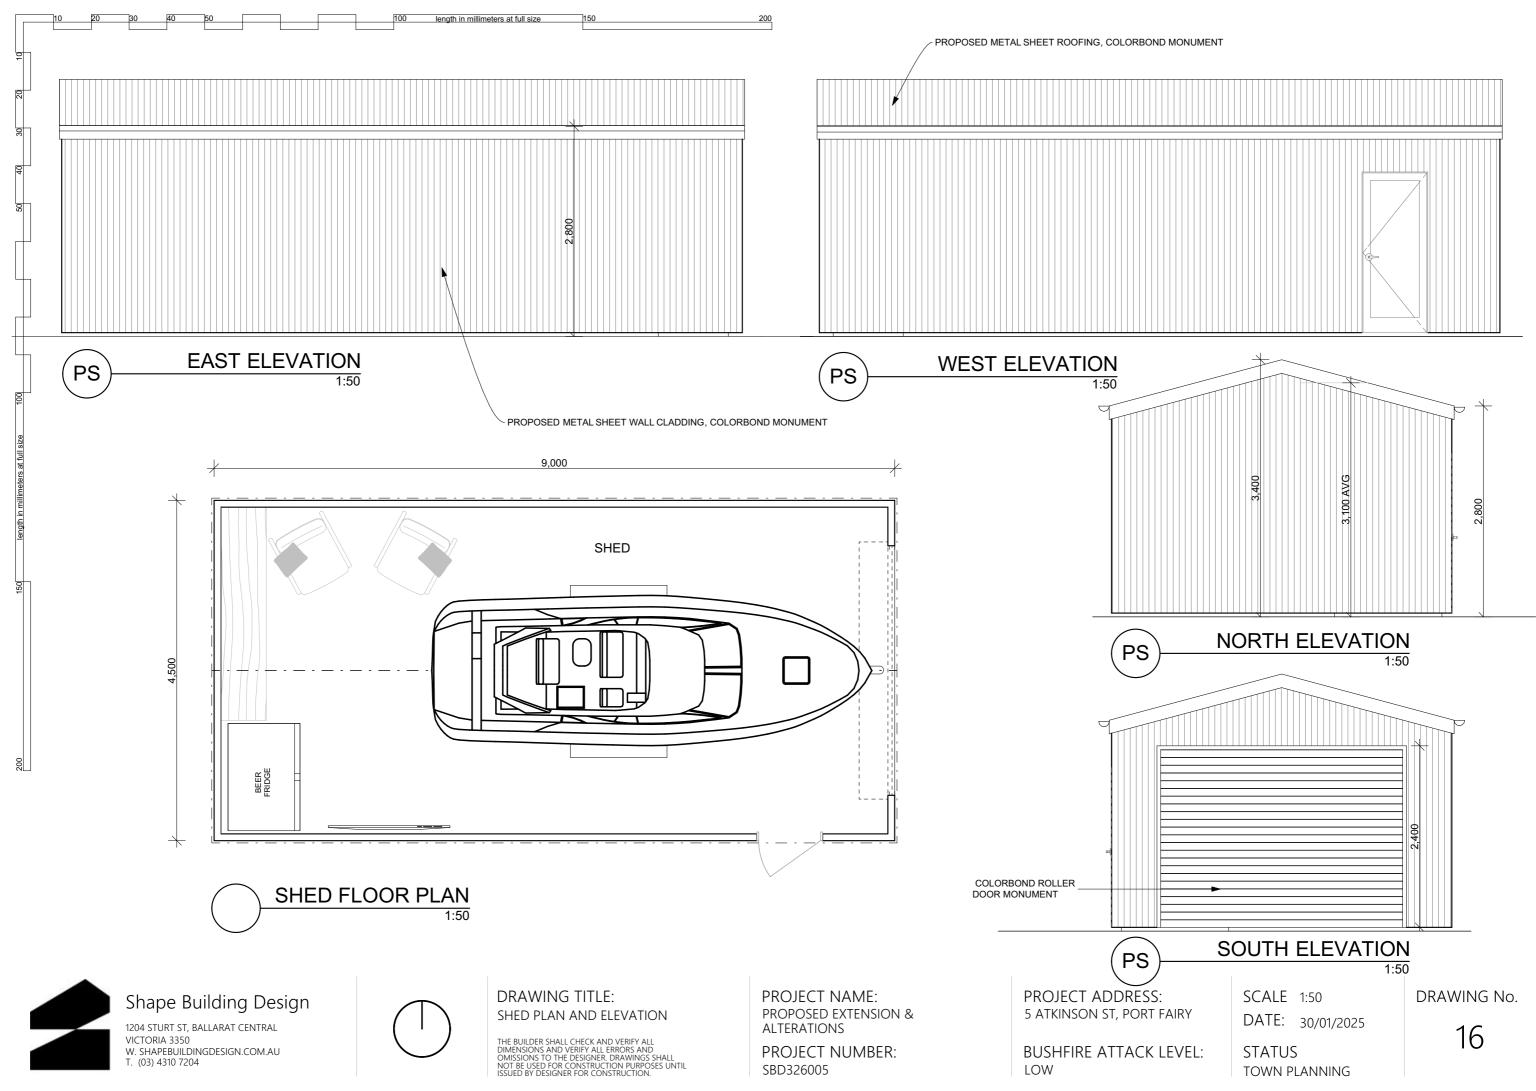



length in millimeters at full size





External Materials \$0.00

200

Wall Cladding	Cemintel Territory Product Name & Cemintel Brand	- Product Code - Lead time	0 Oty	Woodland Grey Gum Colour Prefinished Finish	Cement bonded fibrous particle panel Material
Roofing -	Monument Custom Orb Product Name & Colourbond Brand	- Product Code - Lead time	0 City	Monument Colour - Finish	- Moterial
Render -	Rendered Finish Product Name - Brand	- Product Code - Lead time	0 Oty	Warm White Colour - Finish	- Material
Window Frames	Aluminium Window/Door Frames Product Name	- Product Code - Lead time	O	Black Colour - Finish	- Material



200

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# DRAWING TITLE: EXTERIOR VIEWS & MATERIALS

THE BUILDER SHALL CHECK AND VERIFY ALL DIMENSIONS AND VERIFY ALL ERRORS AND OMISSIONS TO THE DESIGNER. DRAWINGS SHALL NOT BE USED FOR CONSTRUCTION PURPOSES UNTIL ISSUED BY DESIGNER FOR CONSTRUCTION.

PROJECT NAME: PROPOSED EXTENSION & ALTERATIONS

PROJECT NUMBER: SBD326005

PROJECT ADDRESS: 5 ATKINSON ST, PORT FA

BUSHFIRE ATTACK LEVEL: LOW

AIR Y
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SCALE DATE: 30/01/2025 DRAWING No.

17

STATUS TOWN PLANNING